

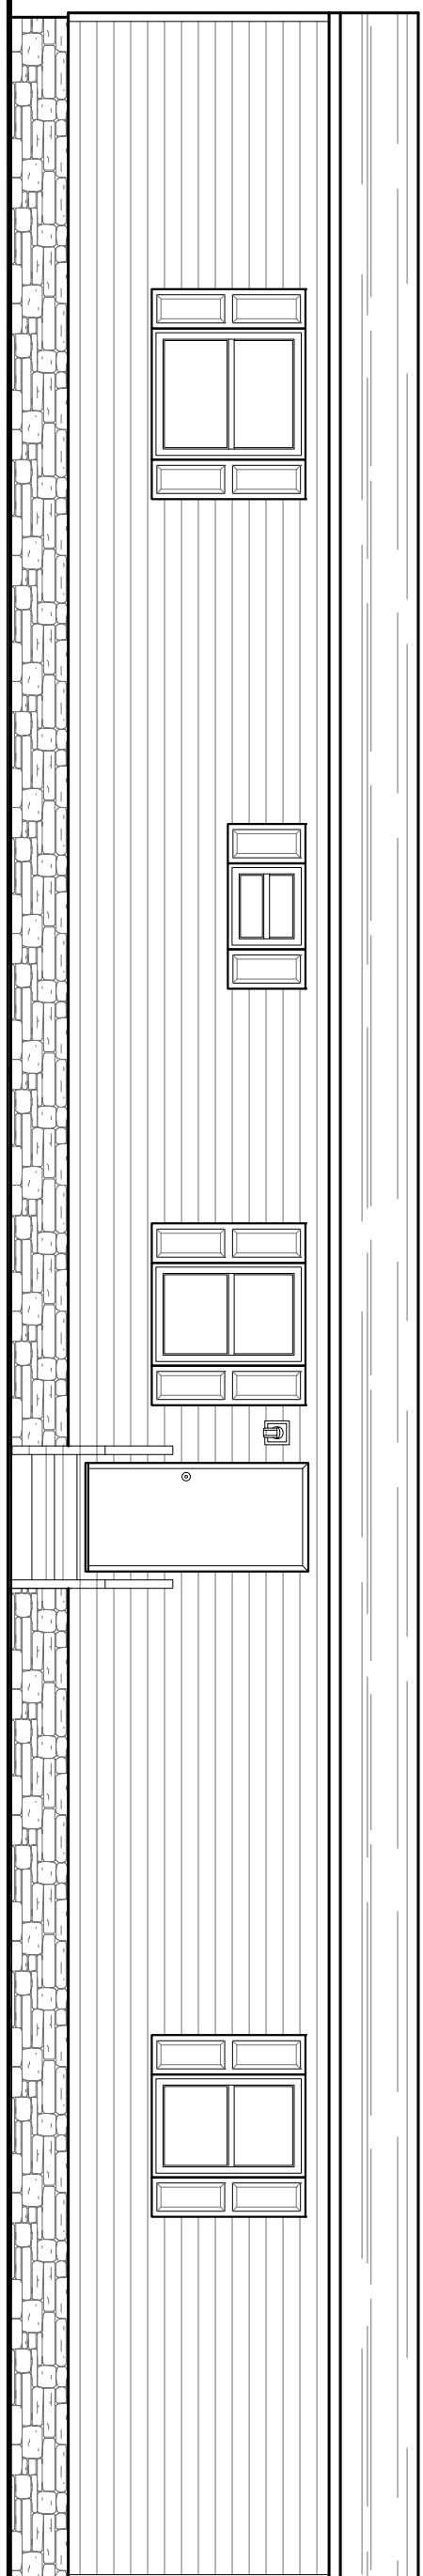


FRONT ELEVATION

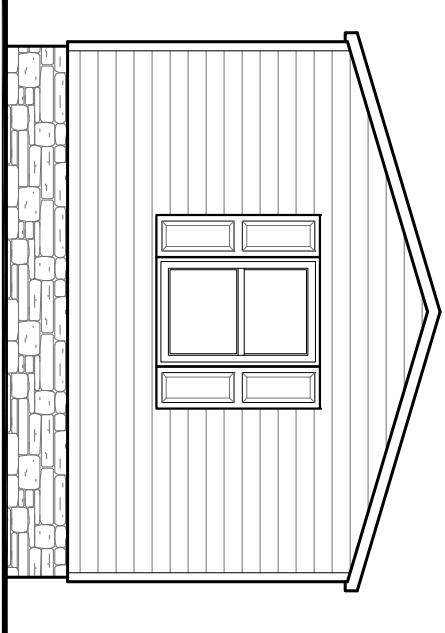


LEFT ELEVATION

RIGHT ELEVATION

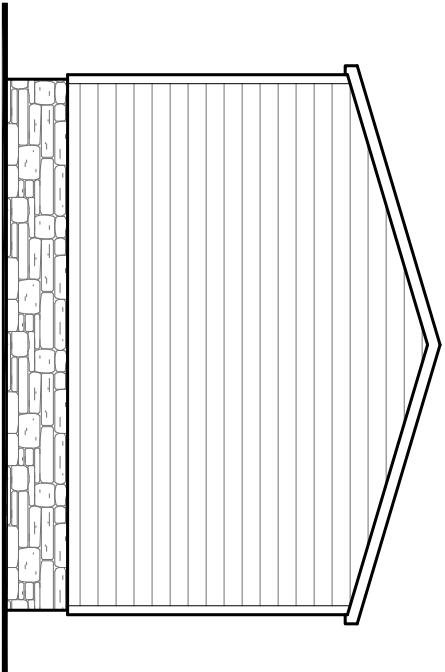

REAR ELEVATION

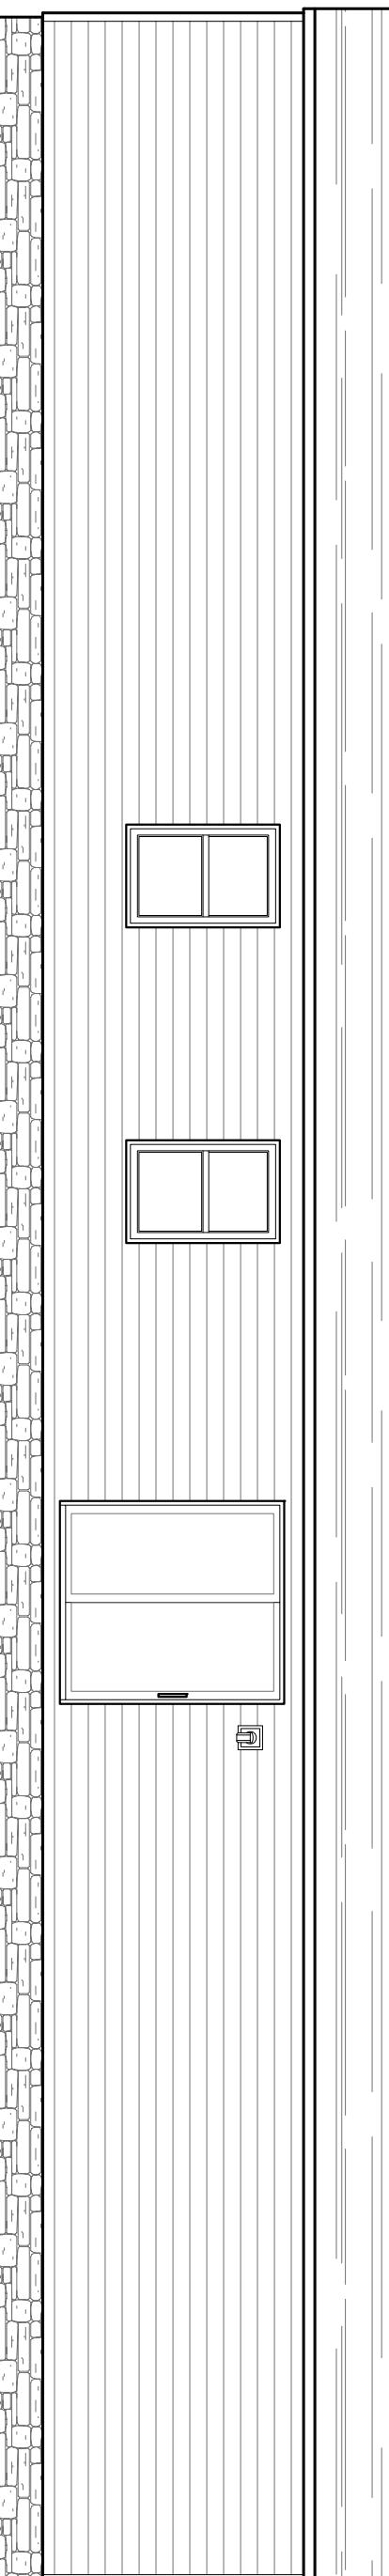

EX-1.


SHEET NO.
TRU-1676-32-2SHEET NAME
EXTERIOR ELEVATION
UNLESS OTHERWISE NOTED
3/16"=1'PLAN NO.
DATE PRINTED
3/25/2024
SCALE
1:64

MODEL NAME	REVISION
Splendor	
MODEL NO.	
TRS16763Z	
BOX SIZE	
16' x 76'	
MODEL SQ. FT.	
1,140	

REVISION	DATE



"Splendor"

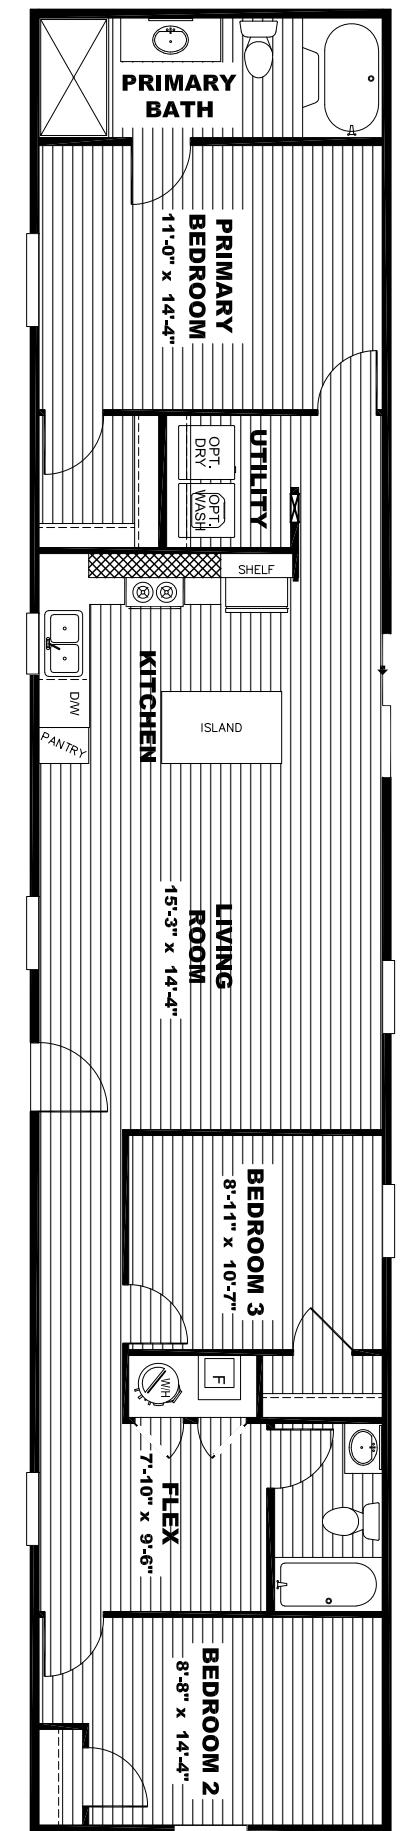


MODEL #TRS16763Z SQ.FT. 1,140

File Path:A:\Product Design\DWG Files\TRUNTRU-1676-322.dwg, Last Saved By:HuiLingJ, Saved Date:3/18/2024 9:39 AM, Date Printed:3/25/24 1:07 PM

DRAWING # TRU-1676-32-2

20 lb ROOF LOAD SIDEWALL OPENING PIER LOAD 16' BOX WIDTH	3	4	5	6	8	10
	1244	1413	1581	1750	2088	2425

*FOR 30 lb & 40 lb ROOF LOAD REFER TO TABLES 7 & 7a IN THE INSTALLATION MANUAL.

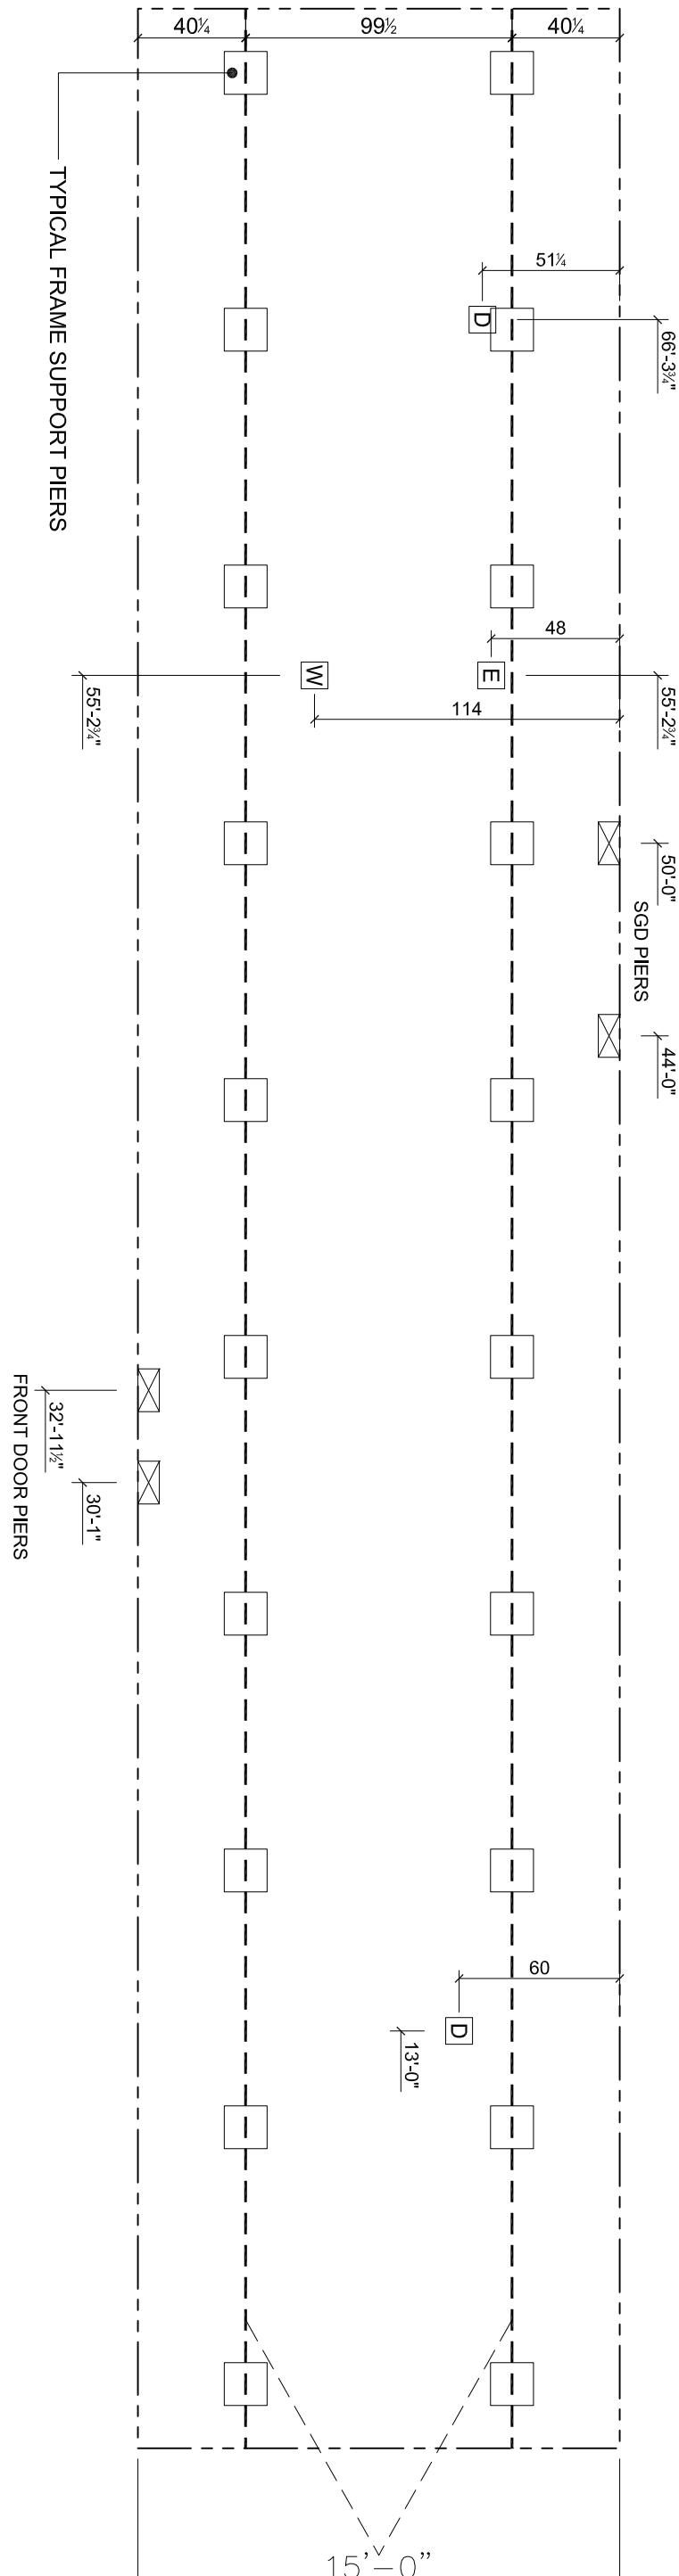

NOTES:

1. REFER TO TABLES 6 AND 6a IN THE INSTALLATION MANUAL FOR LOAD ON FRAME PIER FOOTINGS FOR HOMES THAT DO NOT REQUIRE PERIMETER BLOCKING. REFER TO TABLES 7 AND 7a IN THE INSTALLATION MANUAL FOR LOAD ON FRAME PIER FOOTINGS FOR HOMES THAT REQUIRE PERIMETER BLOCKING. REFER TO TABLES 10 AND 10a TO DETERMINE FOOTING SIZE FOR ALL PIERS.
2. REFER TO TABLE 9 FOR PIER CONFIGURATION AND MAXIMUM ALLOWABLE HEIGHTS. CROSS REFERENCE THE PIER HEIGHT WITH THE MAXIMUM ALLOWABLE FLOOR HEIGHT LISTED IN THE FRAME TIEDOWN CHARTS (TABLE 18, 19, AND 20).
3. THE MAXIMUM SPACING FOR FRAME SUPPORT PIERS FOR 8" I-BEAMS IS 8 FEET; 10" & 12" I-BEAMS IS 10 FEET.
4. SERVICE DROP LOCATIONS IDENTIFIED ARE APPROXIMATE.
5. FLOOR WIDTH SHOWN IS FOR STANDARD PRODUCT ONLY. CONTACT THE MFG FACILITY FOR SPECIFICATIONS OF OPTIONS ORDERED.

PIER LEGEND	
<input type="checkbox"/>	PIER MAN BEAM
<input checked="" type="checkbox"/>	PIER PERIMETER
<input type="checkbox"/>	PIER PORCH/RECESSED ENTRY

GENERAL NOTES:

1. SERVICE DROP LOCATIONS IDENTIFIED ARE APPROXIMATE.

DATE PRINTED	REVISION	DATE
2/21/2024		
SCALE		
3/16"=1'		
PLAN NO.		
TRU-1676-32-2		
SHEET NAME		
PIER PLAN		
SHEET NO.		
SU-1.		

